

Department of Public Works


Bureau of Engineering
Report No. 3

May 19, 2025

CD No. 15

ADOPTED BY THE BOARD
PUBLIC WORKS OF THE CITY
of Los Angeles California

MAY 19 2025

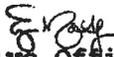
Executive Officer
Board of Public Works

REQUEST FOR A VARIANCE FROM THE ABOVE GROUND FACILITIES ORDINANCE REQUIREMENTS FOR HEIGHT AND VOLUME LIMITATION AND A HARDSHIP WAIVER FROM THE UNDERGROUND REQUIREMENT FOR THE INSTALLATION OF TWO CABINETS AND AN H-FRAME LOCATED ADJACENT TO 4036 S. PACIFIC AVENUE

RECOMMENDING THE BOARD OF PUBLIC WORKS (BOARD):

1. Approve the request for a variance from the height requirement of the Above Ground Facilities (AGF) Ordinance, per Los Angeles Municipal Code (LAMC) Section 62.08.V.B., for two cabinets and an H-Frame.
2. Approve the request for a variance from the volume requirement of the AGF Ordinance, per LAMC Section 62.08.V.B., for two cabinets and an H-Frame.
3. Approve the request for a hardship waiver from the below grade requirement of the AGF Ordinance, per LAMC Section 62.08.II.A., for two cabinets and an H-Frame.
4. Authorize T-Mobile to install two cabinets and H-frame up to 5 feet 11 inches high in the public right-of-way, adjacent to 4036 S. Pacific Avenue.

TRANSMITTALS

1. Variance request dated October 22, 2024, from Network Connex (858 S. Oak Park Road, Suite 100, Covina, CA 91724).
2. Hardship waiver requests, dated October 2, 2024, from Network Connex (858 S. Oak Park Road, Suite 100, Covina, CA 91724).
3. Site plan that shows the proposed monopole with an antenna and other electronic equipment attached and a meter pedestal cabinet.

DISCUSSION

Background

On October 22, 2024, Network Connex, on behalf of T-Mobile, requested a variance from the maximum allowable height of 5 feet 6 inches and the maximum allowable volume of 36 cubic feet of the AGF Ordinance for a proposed two cabinets and a proposed H-frame adjacent to 4036 S. Pacific Ave (Transmittal No. 1). On October 28, 2024, T-Mobile requested a hardship waiver from the below grade requirement of the AGF

Ordinance for the proposed two cabinets and the H-frame (Transmittal No. 2). In addition, Network Connex requested permission to place two 5 feet 11 inches tall cabinets and a 5 feet 6 inches tall H-frame in the public right-of-way (Transmittal No. 3). The new cabinets and the H-frame are replacing an existing cabinet that is 5 feet 7 inches tall and has a volume of approximately 60 cubic feet. The replacement is intended to better support the coverage needs with new technology for the nearby residents. The height increase of 5 inches is due to the addition of cabinet base, which will allow new conduit to be placed under the proposed cabinets rather than having them exposed. per Los Angeles municipal code section 63.08.VB, the maximum allowable AGF height is 5 feet 6 inches and volume of 36 cubic feet. However, the height of the proposed AGF will be 5 feet 11 inches and have a combined volume of 79.01 cubic feet.

On December 14, 2022, T-Mobile deposited \$2,000 for the Bureau of Engineering (BOE) to investigate and process the application.

On December 16, 2022, T-Mobile sent notification letters for the proposed installation to Council District No. 15, Coastal San Pedro Neighborhood Council, the adjoining, abutting, and across the street property owners.

Variance Request

LAMC Section 62.08.V.B. lists three conditions that must be met for the Board to grant a variance from the height and volume limitation:

1. The applicant needs to provide suitable measures consistent with the aesthetic guidelines of the AGF Ordinance and the formal aesthetic requirements adopted by the Board on April 3, 2019, to mitigate for the excessive AGF height/volume.
2. The applicant needs to demonstrate that no financially or technically acceptable alternative exists that complies with LAMC Section 62.08.V.B.
3. The applicant needs to provide approval from the Cultural Affairs Commission for the design of the AGF.

BOE has determined that the height and volume limit variance for the two cabinets should be granted for the following reasons:

1. The AGF installation will not obstruct street scape views, view corridors in the public rights-of-way, view corridors of neighboring lots, or view corridors from the public right-of-way. New equipment will replace existing cabinets on the same concrete pad

May 19, 2025

Page 3

that will be extended by only 2 feet and 4 inches in length. All equipment will be painted to help camouflage with the surrounding area. Condition No.1 is satisfied.

2. Placing the equipment on the existing pad will be the best option both financially and technically. Placing the equipment in an alternative location would require another AGF to be placed on a new concrete pad which would be more disruptive to the neighborhood. Condition No. 2 is satisfied.
3. The Cultural Affairs Commission approved the proposed installation for the site on July 7, 2023. Condition No. 3 is satisfied.

Hardship Waiver Request

This proposed installation is within the San Pedro Specific Plan. LAMC Section 62.08.II.B gives the Board authority to waive the below grade requirement if it finds that technical or financial hardship would result from the imposition of these requirements. According to the hardship waiver request from the applicant, T-Mobile is removing and replacing the existing cabinet with newer models required for the updated technology.

The proposed facility is not within 200 feet of a commercial or manufacturing zone eliminating any building alternatives on a private property. Service maps were submitted to demonstrate that at least 50 percent of the AGF's benefit will be specifically intended to service customers in the restricted area. The Department of City Planning has noted that this AGF is exempt from San Pedro Specific Plan regulations and does not require further review.

BOE Determination

The site location was determined by T-Mobile to be the best technical location with respect to their coverage needs for the area. BOE's review of the AGF application found the site to be compliant with the AGF Ordinance.

On September 26, 2023, T-Mobile sent second notification letters to the adjoining, abutting, and across the street property owners notifying them of BOE's determination that the proposed AGF installation has met the requirements of the AGF Ordinance. The notification informed them that they have 14 calendar days to appeal the determination. Council District No. 15, Coastal San Pedro Neighborhood Council were also notified.

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Page 4

The results of the second notification are shown below:



| Survey of Adjoining, Abutting, and Across the Street Property Owners/Occupants | | | | | |
|---|------------------------------|-----------------------------------|------------|----------------|--------------------|
| Site Address | Request | No. of Properties Involved | Yes | Opposed | No Response |
| 4036 S. Pacific Ave | Hardship Waiver and Variance | 5 | 0 | 1 | 4 |

BOE has received a single appeal from 4029 S. Pacific Ave. The first appeal meeting was on November 29, 2023, and the resident's primary concern was on experiencing potential noise from the proposed cabinets at night.

After hearing the appellants concerns, Network Connex and T-Mobile was able to provide an alternate cabinet solution which has a reduced noise output compared to the standard configuration. The predicted noise rating from this configuration is 48dB at the distance of 6 meters when the fan is in use. The fans are set to turn on at 77 degrees, but the night time temperature at the location rarely reaches that point, hence the noise should not be a concern. The appellant was satisfied with the proposed alternate cabinet solution and withdrew the appeal on September 19, 2024.

Council District No. 15 has not taken a position with respect to this proposal.


May 19, 2025

Page 5

The following photos are before and after photo simulations of the proposed installation:



Existing Elevation Looking East

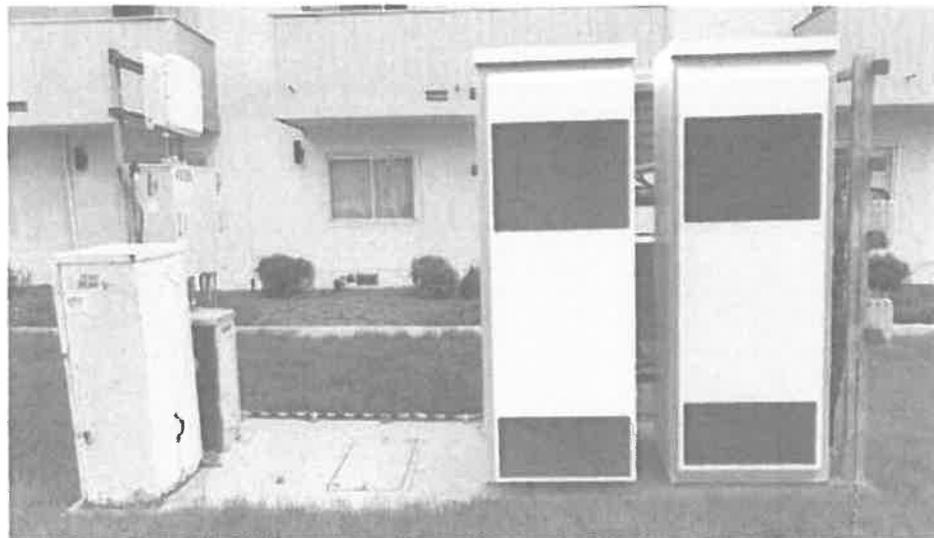

Proposed Elevation Looking East

Report No. 3

Page 6

T-Mobile has met all the conditions required for the variance and hardship waiver request of the AGF Ordinance. Therefore, BOE recommends that the Board may approve the variance request for the site.

(CS VCA BM)

Report reviewed by:

Respectfully submitted,

BOE (ADM)



for

Report prepared by:

Ted Allen, PE
City Engineer

Central District Office

Christine Sotelo, PE
District Engineer
Phone No. (213) 378-1268

CS/TY02-2025-0012_CEN.gva

City Log No. 2022013841
Questions regarding this report
may be referred to:
Tao Yang, Civil Engineer
Phone No. (310) 575-8625
E-mail: tao.yang@lacity.org



Date: 10/22/2024

City of Los Angeles
Department of Public Works
Bureau of Engineering
201 North Figueroa Street, 3rd floor, Suite 300
Los Angeles, CA 90012
Attn: Tao Yang

RE: AGF Volume and Height Variance Request

T-Mobile / LA02944A - Adjacent to 7467026012 (AGF: East on Pacific Ave. North of Shepard St.) BOE Log # 2022013841

T-Mobile is requesting a variance from the volume and height requirement of the Los Angeles Municipal Code for the proposed AGF installation listed above.

1. Suitable measures consistent with the aesthetic guidelines of this report mitigate the excessive AGF volume.

The AGF installation will not obstruct street scape views, view corridors in the public rights-of-way, view corridors of neighboring lots, or view corridors from the public right-of-way. All equipment will be mounted on the existing AGF concrete pad and just extending the pad by 2'4". All equipment will be painted to help camouflage with the surrounding area.

2. The applicant demonstrates that no financially or technically acceptable alternative exists that complies with LAMC 62.08 Section V.B.

Placing the equipment in an alternative location would require another AGF to be placed on a new concrete pad. Placing the equipment on the existing pad will be the best option financially. The volume increase is needed for T-Mobile to upgrade this site as needed to better support the coverage needs with new technology for the nearby residents. The height increase will be required for the new conduit to be placed under the proposed cabinets. The cabinet bases are needed to be able to run the conduit from underneath rather than have exposed conduit. Per Los Angeles municipal code section 63.08.VB the maximum allowable AGF height is 5'6" and volume of 36 cu ft, however the height of the proposed will need to be 5.92' with a volume of 79.01 cu ft.

3. The AGF installation design has been cleared by Cultural Affairs on 3/31/2023.

If you should have any additional questions or concerns, please don't hesitate to contact me directly.
Respectfully,

Colt Waterbury | Permit Expeditor Network Connex
858 S. Oak Park Road, Suite 100 | Covina, CA 91724 c: 626.537.0184 |
e: cwaterbury@networkconnex.com

Transmittal No. 1

October 2nd, 2024

RE: AGF Installation

Application Log

Number:2022013841

Pacific Ave. and Shepard St.

Attention: AGF Permit Group

T-Mobile is requesting a hardship waiver from the under grounding requirement of Los Angeles Municipal Code Section 63.08.II.C for the proposed AGF installation listed above.

1. Section (II)(C)(1): T-Mobile is requesting a variance from the under grounding requirement to upgrade the existing equipment. T-Mobile is removing and replacing the existing cabinet with the new models required for the updated technology.
2. Section (II)(C)(3): There is no private property locations that are willing to allow the placement of the proposed cabinets on their property. The proposed facility is not within 200' of a commercial or manufacturing zone.
3. Section 62.08.II.C.4: We have included propagation maps showing the existing and proposed new service area within the specific plan area.

For the foregoing reasons, we are requesting for a variance from the undergrounding requirements. If you have any questions regarding the above statements, please contact me at (626) 537-0184 Or cwaterbury@networkconnex.com

Transmittal No. 2

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NETWORK CONNEX

DATE: 01-03-23
ENGINEER DATE: 01-03-23
DRAFTED BY: Z.S.

NO. DATE BY
1 01-03-23 Z.S.
EQUIPMENT FOR
CITY OF LA


2 04-28-23 A.M.
100% CD

3 05-03-23 Z.S.
UPDATED TO 61660_JG_VF

SITE INFORMATION:
LA02944A
ANCHOR
4036 S PACIFIC AVE.
SAN PEDRO, CA 90731

SHEET TITLE: SITE PLAN AND DETAILS
SHEET NUMBER: A-1

10' 20'

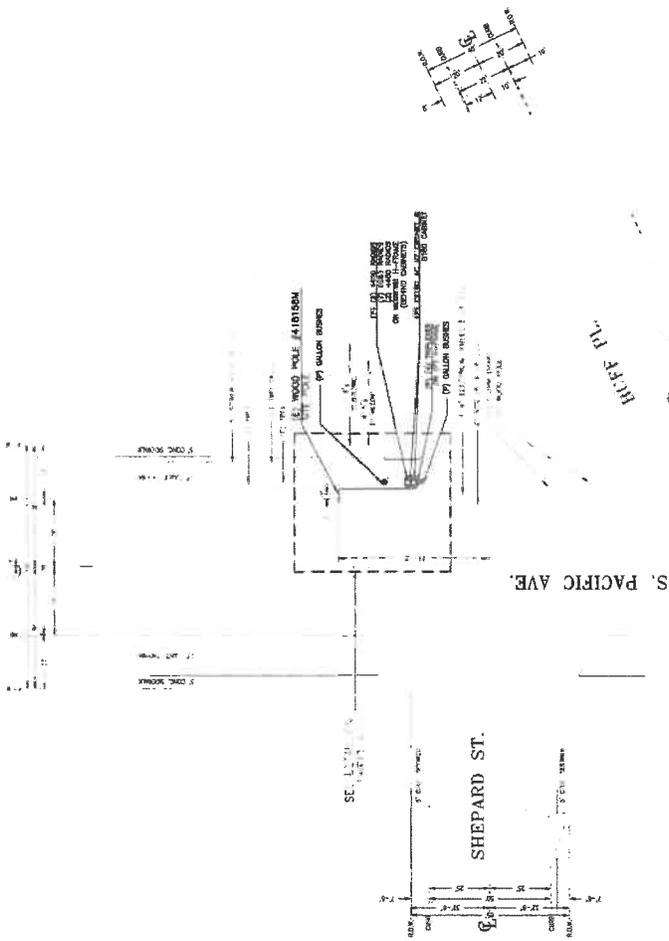

SITE PLAN

SCALE 1" = 20'

NOTE: ONLY THOSE EXISTING SUBSTRUCTURES WITHIN 10' OF THE PROPOSED CIRCUIT ARE SHOWN

NOTE: NEW SIDEWALK TO FOLLOW CITY STANDARD S-444-0



CONSTRUCTION NOTE
LOCATION OF SUBSTRUCTURES AS SHOWN MAY NOT BE EXACT. THE SPECIFIC LOCATIONS AND DEPTHS OF EXISTING UTILITIES SHALL BE DETERMINED BY THE CONTRACTOR BEFORE INITIATING WORK.

T-Mobile
Get more from life

NETWORK
CONNEX

DATE: 01-03-23
 ENGINEER/DRAWN: 01-03-23
 DRAFTED BY: Z.S.
 NO. DATE BY:
 01-03-23 Z.S.
 EQUIPMENT FOR
 CITY OF LA
 04-28-23 T.A.M.
 100% CD
 09-03-24 Z.S.
 UPDATED TO 16160.AC.37
 4
 5
 6
 7

STATION INFORMATION:
LA02944A
ANCHOR
 4035 S PACIFIC AVE.
 SAN PEBRO, CA 90731
 STAMP:


SHEET TITLE: **SITE ELEVATIONS**
 SHEET NUMBER: **A-5**

PROPOSED EQUIPMENT

| DESCRIPTION (U.S. & SI UNITS) | QUANTITY | UNITS (U.S.) | UNITS (SI) |
|------------------------------------|----------|--------------|------------|
| 20" x 20" x 12" (508 x 508 x 305) | 1 | 1000.00 | 1000.00 |
| 12" x 12" x 6" (305 x 305 x 152) | 1 | 1000.00 | 1000.00 |
| 6" x 6" x 3" (152 x 152 x 76) | 1 | 1000.00 | 1000.00 |
| 3" x 3" x 1.5" (76 x 76 x 38) | 1 | 1000.00 | 1000.00 |
| 1.5" x 1.5" x 0.75" (38 x 38 x 19) | 1 | 1000.00 | 1000.00 |
| TOTAL | 5 | 5000.00 | 5000.00 |

EXISTING EQUIPMENT

| DESCRIPTION (U.S. & SI UNITS) | QUANTITY | UNITS (U.S.) | UNITS (SI) |
|------------------------------------|----------|--------------|------------|
| 20" x 20" x 12" (508 x 508 x 305) | 1 | 1000.00 | 1000.00 |
| 12" x 12" x 6" (305 x 305 x 152) | 1 | 1000.00 | 1000.00 |
| 6" x 6" x 3" (152 x 152 x 76) | 1 | 1000.00 | 1000.00 |
| 3" x 3" x 1.5" (76 x 76 x 38) | 1 | 1000.00 | 1000.00 |
| 1.5" x 1.5" x 0.75" (38 x 38 x 19) | 1 | 1000.00 | 1000.00 |
| TOTAL | 5 | 5000.00 | 5000.00 |

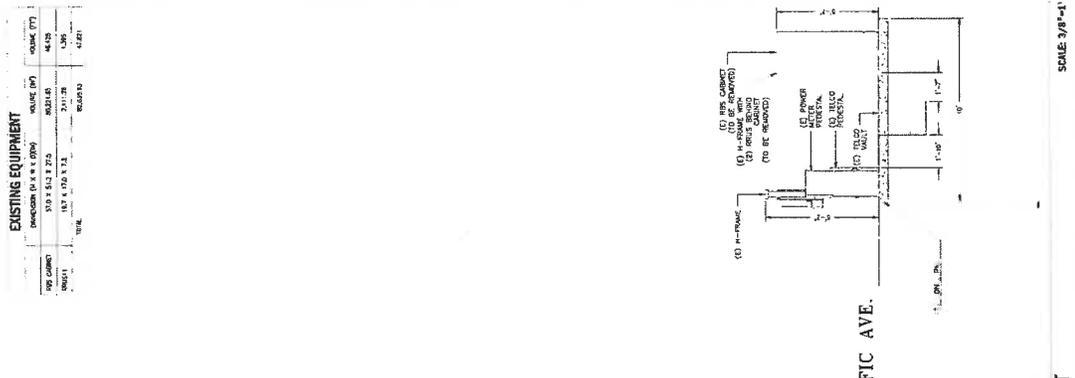

PROPOSED EQUIPMENT

| DESCRIPTION (U.S. & SI UNITS) | QUANTITY | UNITS (U.S.) | UNITS (SI) |
|------------------------------------|----------|--------------|------------|
| 20" x 20" x 12" (508 x 508 x 305) | 1 | 1000.00 | 1000.00 |
| 12" x 12" x 6" (305 x 305 x 152) | 1 | 1000.00 | 1000.00 |
| 6" x 6" x 3" (152 x 152 x 76) | 1 | 1000.00 | 1000.00 |
| 3" x 3" x 1.5" (76 x 76 x 38) | 1 | 1000.00 | 1000.00 |
| 1.5" x 1.5" x 0.75" (38 x 38 x 19) | 1 | 1000.00 | 1000.00 |
| TOTAL | 5 | 5000.00 | 5000.00 |



2 | PROPOSED ELEVATION LOOKING EAST

SCALE: 3/8"=1'

1 | EXISTING ELEVATION LOOKING EAST

SCALE: 3/8"=1'

T-Mobile
Get more from fiber



**NETWORK
CONNEX**

| | |
|----------------|-------------------------|
| DATE: | 01-03-23 |
| ENGINEER DATE: | 01-03-23 |
| DRAWN BY: | Z.S. |
| NO.: | 1 |
| DATE: | 01-03-23 Z.S. |
| BY: | EQUIPMENT FOR |
| | CITY OF LA |
| 2 | 04-28-23 A.M. |
| | 100% CD |
| 3 | 09-03-24 Z.S. |
| | UPDATED TO 06190 JAL VZ |
| 4 | |
| 5 | |
| 6 | |
| 7 | |

SITE INFORMATION:
LA02944A
ANCHOR
4035 S PACIFIC AVE
SAN PEDRO, CA 90731
STAMP:

SHEET TITLE:
AZIMUTH
DETAILS
SHEET NUMBER:
A-6

SCALE: 3/4"=1'

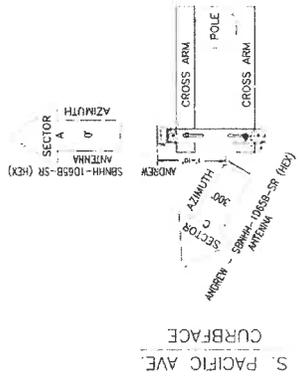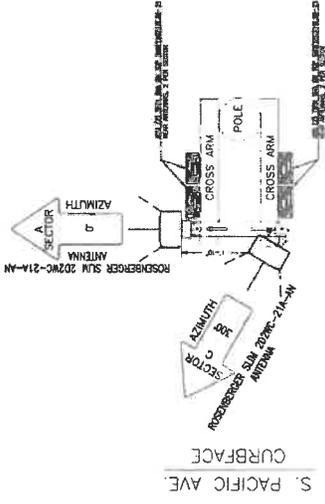

SCALE: 3/4"=1' | **2 | PROPOSED AZIMUTH**

1 | EXISTING AZIMUTH

DATE: 01-03-23
ENGINEER DATE: 01-03-23
DRAFTED BY: Z.S.

NO. 01
DATE: 01-03-23
EQUIPMENT FOR: CITY OF LA

2 04-29-23 A.M.
10:12:00

3 09-03-24 Z.S.
UPDATED TO E6160_AC_V2

4
5
6
7

SITE INFORMATION:
**LA02944A
ANCHOR**
4036 S PACIFIC AVE.
SAN PEDRO, CA 90731


SHEET TITLE: **EQUIPMENT
DETAILS**
SHEET NUMBER: **D-2**

ERICSSON BASE STATION UNIT 6601

ENCLOSURE HEIGHT: 48 INCH
ENCLOSURE WIDTH: 18" x 23" H x 13.75" D
WEIGHT: UP TO 103.5 lbs

NOTES:

- DEPENDS ON MOUNTING INFORMATION, EXTERNALLY MOUNTED IN A 18" Hx 23" Hx 13.75" D ENCLOSURE
- CAN MOUNT AND RUN UNIT ON TWO THUMBOLLS MOUNTS
- ENCLOSURE HEIGHT IS 48" WITH 2" CLEARANCE TO THE TOP OF THE UNIT
- UP TO 103.5 LBS CAN BE CARRIED TO ONE MOUNT UNIT
- ENCLOSURE WEIGHT IS 103.5 LBS
- MULTIPLE MOUNTS ARE AVAILABLE UP TO 103.5 LBS
- ENCLOSURE WEIGHT IS 103.5 LBS
- CONTACT YOUR LOCAL DISTRIBUTOR FOR MOUNTING AND CONTROL INFO.

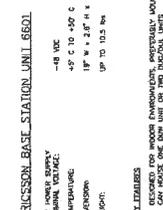SCALE: N.T.S.



B160 INSTALLATION HOLES PATTERN

B160 W/ DOOR OPEN

ISOMETRIC

SPECIFICATIONS

MODEL: ENCLOSURE B160
HEIGHT: 63.0"
WIDTH: 25.5"
DEPTH: 25.5"
WEIGHT: 220 lbs

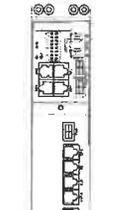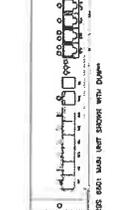SCALE: N.T.S.

6160 INSTALLATION HOLES PATTERN

6160 W/ DOOR OPEN

ISOMETRIC

SPECIFICATIONS

MODEL: ENCLOSURE E6160_AC_V2
HEIGHT: 63.0"
WIDTH: 25.5"
DEPTH: 33.5"
WEIGHT: 374 lbs




SCALE: N.T.S.

3 ERICSSON BASE STATION 6601



UTHPM-TALL-BF-KIT
INCLUDES BOTH FRAMES (SXX 125 5009/1 + SXX 125 5010/1)

ENCLOSURE 6160 12" BASE FRAME (SXX 125 5009/1)
NOTE: E6160 HAS A 4" BASE FRAME THAT MUST BE REMOVED

ENCLOSURE B160 8" BASE FRAME (SXX 125 5010/1)
NOTE: B160 HAS A WELDED LOW 4" BASE FRAME THAT CAN'T BE REMOVED. HENCE 8" ONLY TO MATCH HEIGHT OF E6160 WITH TALL BASE FRAME

WEIGHT: 33 kg (73 lbs)

WEIGHT: 27 kg (60 lbs)

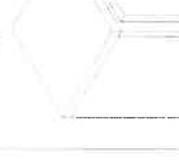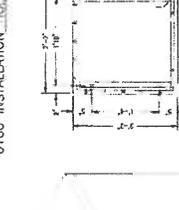SCALE: N.T.S.

2 ERICSSON ENCLOSURE B160



ERICSSON BASEBAND UNIT 6651

ENCLOSURE HEIGHT: 48 INCH
ENCLOSURE WIDTH: 18" x 23" H x 13.75" D
WEIGHT: UP TO 103.5 lbs

ISOMETRIC

SPECIFICATIONS

MODEL: ENCLOSURE B160
HEIGHT: 63.0"
WIDTH: 25.5"
DEPTH: 25.5"
WEIGHT: 220 lbs

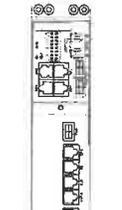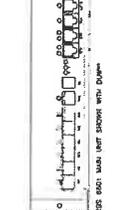SCALE: N.T.S.

1 ERICSSON ENCLOSURE E6160_AC_V2

NOKIA IXXE UNIT

ENCLOSURE HEIGHT: 48 INCH
ENCLOSURE WIDTH: 18" x 23" H x 13.75" D
WEIGHT: UP TO 103.5 lbs

ISOMETRIC

SPECIFICATIONS

MODEL: ENCLOSURE E6160_AC_V2
HEIGHT: 63.0"
WIDTH: 25.5"
DEPTH: 33.5"
WEIGHT: 374 lbs




SCALE: N.T.S.

6 E6160 AND B160 BASE FRAME

SCALE: N.T.S.

5 ERICSSON BASEBAND 6651

SCALE: N.T.S.

4 IXXE ROUTER

SCALE: N.T.S.


Get more from life

NETWORK CONNEX

DATE: 01-03-23
ENGINEER DATE: 01-03-23
DRAFTED BY: Z.S.
NO. 1 DATE: 01-03-23 BY: Z.S.
EQUIPMENT FOR:
CITY OF LA
2 04-28-23 A.M.
100% CD
3 09-03-24 Z.S.
UPDATED TO E61.60.AC.V2

SITE INFORMATION:
LA02944A
ANCHOR
4036 S PACIFIC AVE.,
SAN PEDRO, CA 90731
STAMP:

SHEET TITLE: MOUNTING DETAILS
SHEET NUMBER: D-3

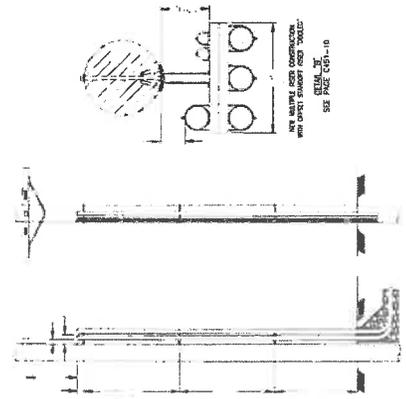

NOTES:
1. THIS DETAIL IS FOR THE USE OF THE CITY OF LA.
2. THIS DETAIL IS SUBJECT TO THE APPROVAL OF THE CITY OF LA.
3. THIS DETAIL IS SUBJECT TO THE APPROVAL OF THE CITY OF LA.
4. THIS DETAIL IS SUBJECT TO THE APPROVAL OF THE CITY OF LA.
5. THIS DETAIL IS SUBJECT TO THE APPROVAL OF THE CITY OF LA.


2 STANDOFF SUPPORT DETAIL

SCALE: N.T.S.

SCALE: N.T.S.

SCALE: N.T.S.

SCALE: N.T.S.

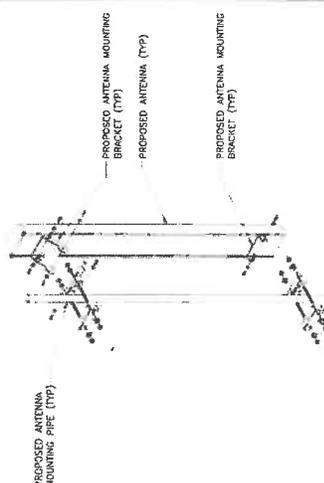

1 ANTENNA MOUNTING DETAIL

SCALE: N.T.S.

SCALE: N.T.S.

SCALE: N.T.S.

SCALE: N.T.S.

SCALE: N.T.S.




SCALE: N.T.S.

DATE: 01-03-23
ENGINEER DATES: 01-03-23
DRAWN BY: Z.S.
NO. 1 DATE: 01-03-23 BY: Z.S.
EQUIPMENT FOR: CITY OF LA
2 04-28-23 A.M.
1-02-00

3 09-03-24 Z.S.
UPDATED TO E6160JALVZ


SHEET INFORMATION:
**LA02944A
ANCHOR**
4032 S PACIFIC AVE
SAN PEDRO, CA 90731
STAMP.

SHEET TITLE:
**H-FRAME
DETAILS**
SHEET NUMBER:
D-4

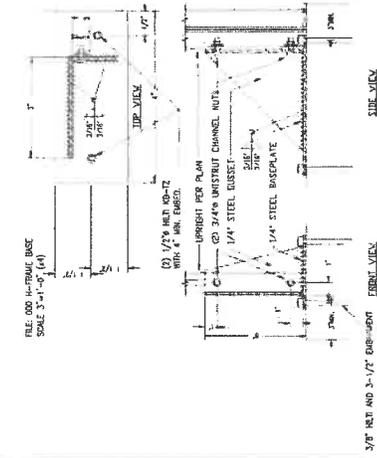

SCALE: N.T.S.

2 H-FRAME BASE

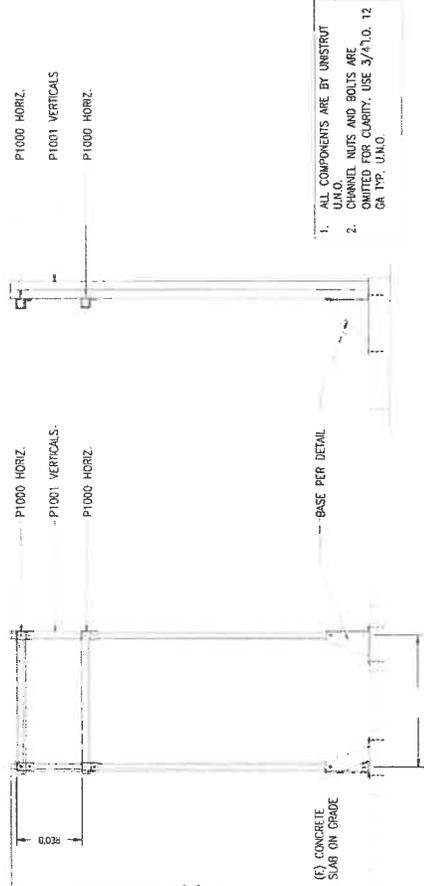


SCALE: N.T.S.

1 H-FRAME




SCALE: N.T.S.

5 NOT USED

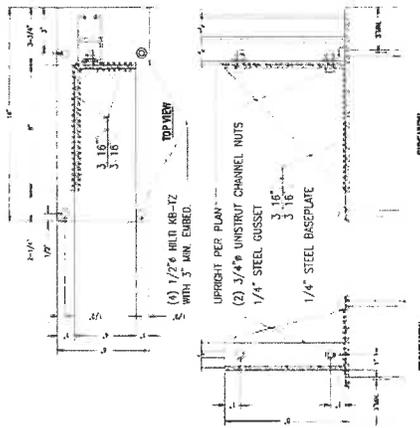

SCALE: N.T.S.

4 H-FRAME BASE DETAIL

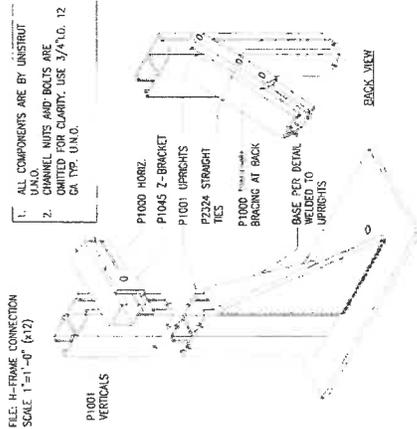

SCALE: N.T.S.

3 H-FRAME CONNECTION

T-Mobile
Get more from life

**NETWORK
CONNEK**
FOR THE NETWORK

DATE: 01-03-23
ENGINEER DATE: 01-03-23
DRAWN BY: Z.S.

NO.: 01-03-23 Z.S.
BY: Z.S.
EQUIPMENT FOR:
CITY OF LA
1104A CD

3 05-03-24 Z.S.
UPDATED TO E6160_A_CV2

4

5

6

7

SITE INFORMATION:



**LA02944A
ANCHOR**

4035 S PACIFIC AVE.
SAN PEDRO, CA 90731
STAMP:

SHEET TITLE:
**EQUIPMENT
DETAILS**

SHEET NUMBER:
D-5

| EXISTING GROUND EQUIPMENT | DIMENSIONS | CUBIC FEET |
|---------------------------|-----------------------|------------|
| RBS 3106 CABINET | 60" x 51.0" x 20" | 62.1 FT |
| TOTAL | 61.332 M ³ | 32.69 FT |

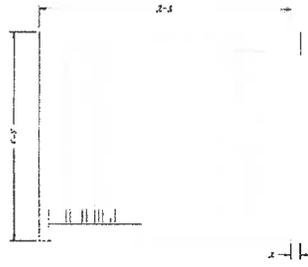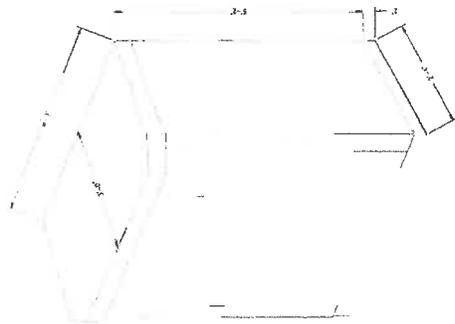

1 RBS 3106 CABINET

T-Mobile
Get more from life

NETWORK
CONNEX

743 2nd Street, Suite 200, San Diego, CA 92101

DATE: 01-03-23

ENGINEER: Z.S.

DRAWN BY: Z.S.

NO. 1

DATE: 01-03-23

BY: Z.S.

EQUIPMENT FOR

CITY OF LA

01-28-23 A.M.

100% CD

09-03-24 Z.S.

UPDATED TO 16180L6_2

4

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SITE INFORMATION:

LA02944A

ANCHOR


403 S. PACIFIC AVE.

SAN PEDRO, CA 90731

STAMP:

SHEET TITLE: RFDS

SHEET NUMBER: E-1

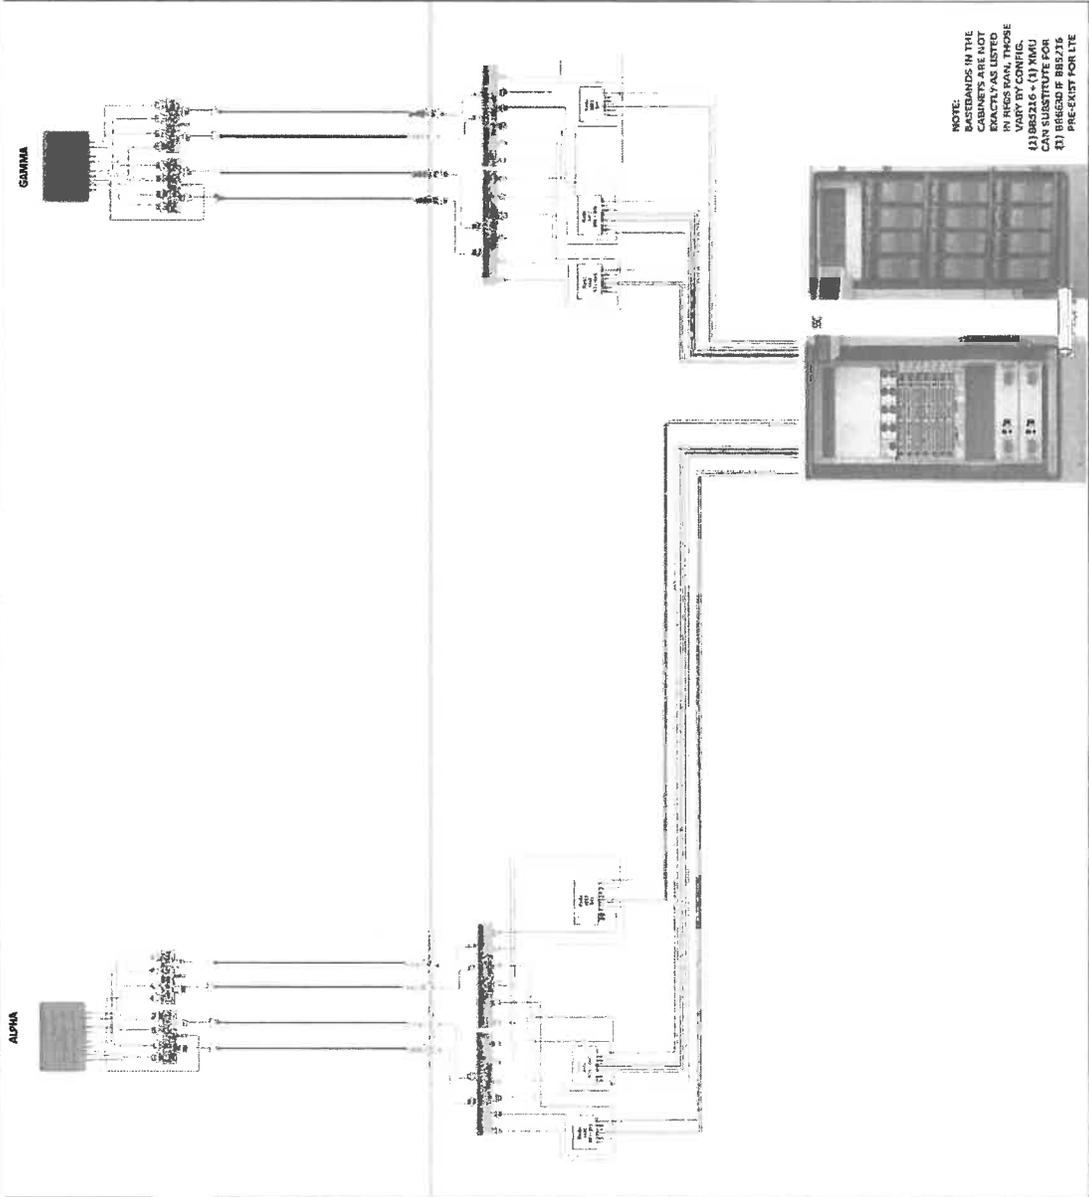

T-Mobile
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**NETWORK
CONNEX**

DATE: 01-03-23
ENGINEER DATE: 01-03-23
DRAFTED BY: Z.S.

NO.: 01-03-23
DATE: 01-03-23
BY: Z.S.
EQUIPMENT FOR: CITY OF LA

04-28-23 A.M.
TO: C.

3 09-03-24 Z.S.
UPDATED TO E6160 AC V2

4

5

6

7

SITE INFORMATION:


LA02944A
ANCHOR

4038 S PACIFIC AVE.,
SAN PEDRO, CA 90731

STAMP:

SHEET TITLE:
RF SIGNAGE
DETAILS

SHEET NUMBER:
E-2

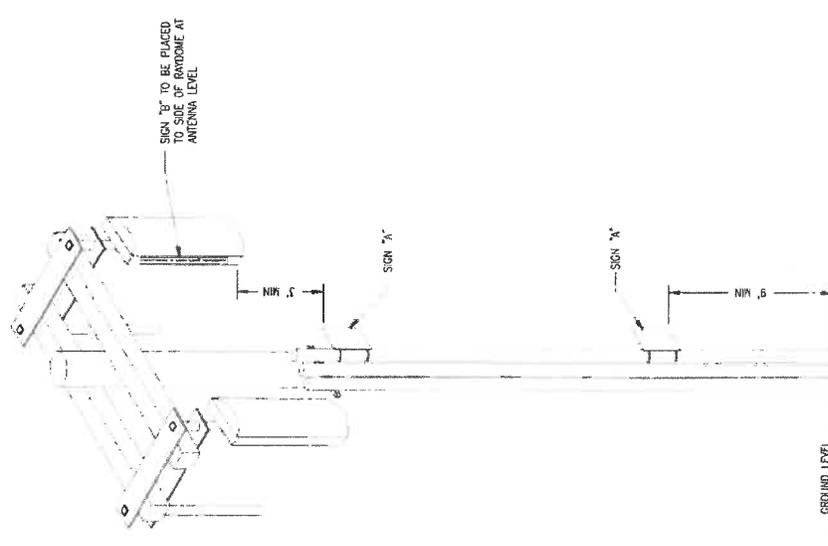

MOUNTING HOLES, TYP
(AS REQ'D)
METAL W/DRAKED
ENAMEL FINISH



The Radio Frequency (RF) emissions at this site have been evaluated for potential RF exposure to personnel who may be working near these antennas.

RF exposure of 3 feet or closer to the face of the antenna may exceed the FCC public exposure standard and thus only qualified RF workers may work in this 3 foot exclusion zone. Others who need to work in the exclusion zone should contact:

T-MOBILE at (888) 682-4662

Follow their instructions prior to performing any maintenance or repairs closer than 3 feet from antennas.

This is T-Mobile sites:



SIGN 'B'
SIGN 'B' IS TO BE MADE ON A NON-METALLIC LABEL WITH A MINIMUM OF 1/8" THICK MATERIAL WITH BE VINYL OR SIMILAR WATERPROOF MATERIAL.

1. SIGN 'B' IS TO BE MADE ON A NON-METALLIC LABEL WITH A MINIMUM OF 1/8" THICK MATERIAL WITH BE VINYL OR SIMILAR WATERPROOF MATERIAL.
2. SIZE SHALL BE 1 1/2" BY 24"

SIGN 'A'
SHEETING

1. SIGN 'A' IS TO BE MADE ON 1/2" ALUMINUM SHEETING
2. SIZE SHALL BE 9" BY 12" WITH 3/16" MOUNTING HOLES IN EACH CORNER OF THE SIGN FOR OPTIONAL MOUNTING
3. SIGN SHALL COMPLY WITH ANSI CS52 COLOR, SYMBOL, AND CONTENT CONVENTIONS.

1] JOINT UTILITY POLE ANTENNA SIGNAGE PLACEMENT

